

PROPOSED BASIN ---- MAXIMUM WATER LEVEL ---- MINIMUM TOP OF BANK Om 2m 10m Scale: 1:250 HORZ. @ A3

SECTIONS KEY

— EXISTING SURFACE



NOTES:

- THIS DRAWING IS TO BE READ IN CONJUNCTION WITH THE RELEVANT SPECIFICATION AND ALL OTHER RELATED DRAWINGS ISSUED BY THE ENGINEER.
- DO NOT SCALE FROM THIS DRAWING. WORK FROM FIGURED DIMENSIONS ONLY
- ALL DIMENSIONS SHOWN ON THIS DRAWING ARE IN METRES UNLESS OTHERWISE STATED.
- 4. ALL LEVELS STATED ARE IN METRES ABOVE ORDNANCE DATUM.
- ALL DIMENSIONS, LEVELS AND SURVEY GRID CO-ORDINATES ARE TO BE CHECKED ON SITE AND THE ENGINEER NOTIFIED IMMEDIATELY OF ANY DISCREPANCIES PRIOR TO THE COMMENCEMENT OF THE WORKS.
- PRIOR TO THE COMMENCEMENT OF THE WORKS, THE CONTRACTOR MUST CHECK THE INVERT LEVELS OF THE EXISTING SPURS AND MANHOLE CHAMBERS TO WHICH ANY CONNECTIONS ARE TO BE MADE. ANY DISCREPANCIES SHALL BE REPORTED TO THE ENGINEER IMMEDIATELY.
- 7. NO DEVIATION FROM THE DETAILS SHOWN ON THIS DRAWING IS PERMITTED WITHOUT PRIOR PERMISSION FROM THE ENGINEER.
- THE CONTRACTOR SHALL UNDERTAKE SUCH MATERIALS TESTING AS INDICATED IN THE SPECIFICATIONS AND SHALL INCLUDE THE COST OF TESTING IN THE TENDER
- 9. UNLESS STATED OTHERWISE, ALL EXCAVATED MATERIAL SHALL BE DISPOSED OF AT AN APPROVED TIP OFF-SITE
- 10. THE PUBLIC HIGHWAY AND WORKS WILL BE KEPT CLEAN AND FREE OF DEBRIS BY USE OF WHEEL WASHING FACILITIES AND ROAD SWEEPERS TO THE COUNCIL'S SATISFACTION

- 11. UPON COMPLETION OF THE WORKS, THE CONTRACTOR SHALL UNDERTAKE ALL NECESSARY MAINTENANCE REPAIRS TO RETURN THE HIGHWAY TO ITS FORMER CONDITION
- 12. THE CONTRACTOR SHALL BE RESPONSIBLE FOR OBTAINING ALL NECESSARY APPROVALS FROM THE LOCAL AUTHORITY PRIOR TO COMMENCING WORKS ON EXISTING OR PARTLY CONSTRUCTED ADOPTABLE HIGHWAY
- 13. ALL EXISTING LEVELS, GRADIENTS, DEPTHS ETC. TO BE CHECKED ON SITE PRIOR TO CONSTRUCTION AND ANY DISCREPANCIES TO BE REPORTED TO THE ENGINEER IMMEDIATELY.
- 14. THE SETTING OUT OF THE DRAINAGE WORKS IS TO BE AGREED ON-SITE WITH THE ENGINEER, PRIOR TO THE COMMENCEMENT OF THE WORKS.
- 15. THE CONTRACTOR SHALL TAKE ALL NECESSARY PRECAUTIONS TO PROTECT THE DRAINAGE WORKS FOR THE DURATION OF THE CONTRACT.
- 16. THE CONTRACTOR SHALL CONTACT ALL OF THE APPROPRIATE STATUTORY UNDERTAKERS AND ESTABLISH THE EXACT LOCATION OF ALL SERVICES, PRIOR TO THE COMMENCEMENT OF THE WORKS, BY HAND DUG TRIAL PITS.
- 17. ALL MATERIALS AND WORKMANSHIP SHALL COMPLY FULLY WITH THE MANUAL OF CONTRACT DOCUMENTS FOR HIGHWAY WORKS, VOLUME ONE, SPECIFICATION FOR HIGHWAY WORKS AND THE LOCAL AUTHORITY SPECIFICATION FOR ROAD CONSTRUCTION AND STANDARD DETAILS.
- 18. THE CONTRACTOR SHALL UNDERTAKE SUCH MATERIALS TESTING AS INDICATED IN THE SPECIFICATIONS AND SHALL INCLUDE THE COST OF TESTING IN THE TENDER.
- UNLESS STATED OTHERWISE, ALL EXCAVATED MATERIAL NOT SUITABLE FOR RE-USE SHALL BE DISPOSED OF AT AN APPROVED TIP OFF-SITE.

CDM NOTES


- THE ATTENTION OF THE CLIENT AND THE PRINCIPAL CONTRACTOR IS DRAWN TO THE FOLLOWING POTENTIAL RISKS IN CONJUNCTION WITH THE PROPOSED ON-SITE AND OFF-SITE WORKS AS DESIGNED FOR THIS PROJECT.
- 2. WORKS IN THE VICINITY OF LIVE SERVICES WILL BE NECESSARY AND THE ADVICE OF ALL STATUTORY SERVICE COMPANIES MUST BE SOUGHT BEFORE ANY WORKS COMMENCE.
- 3. WORKS WITHIN AND ABUTTING THE EXISTING HIGHWAY WILL ENTAIL TRAFFIC HAZARDS AND ALL APPROPRIATE SAFETY MEASURES INCLUDING BARRIERS, SIGNS AND LIGHTING MUST BE UNDERTAKEN TO THE APPROVAL OF THE LOCAL AUTHORITY, THE HIGHWAY AUTHORITY AND THE POLICE
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- 5. THE CONTRACTOR WILL BE RESPONSIBLE FOR LOCATING ALL EXISTING SERVICES WITHIN THE VICINITY OF THE WORKS AND ENSURE THESE ARE PROTECTED THROUGHOUT THE DURATION OF THE WORKS. ALL UTILITY PLANT SHOULD BE CLEARLY MARKED ON THE GROUND PRIOR TO COMMENCEMENT OF THE WORKS.
- THE CONTRACTOR MUST ENSURE ALL WORKING AREAS ARE FULLY SECURE.



| SECTION | SECTION | Secure | Date | Designed by | 1:250 | JUNE 2020 | AW

Drawn by AW Checked by Approved by BB

Drawing Number 162101-022 Rev -

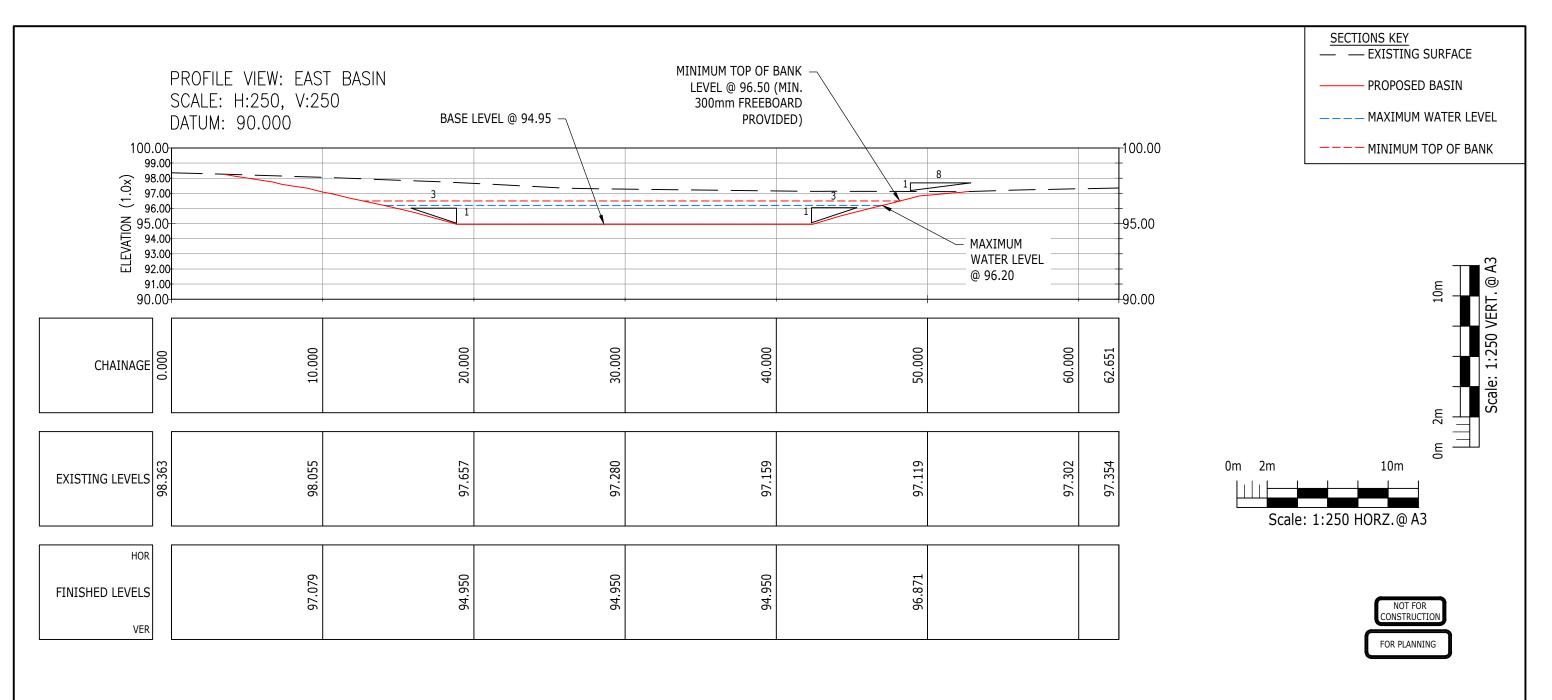

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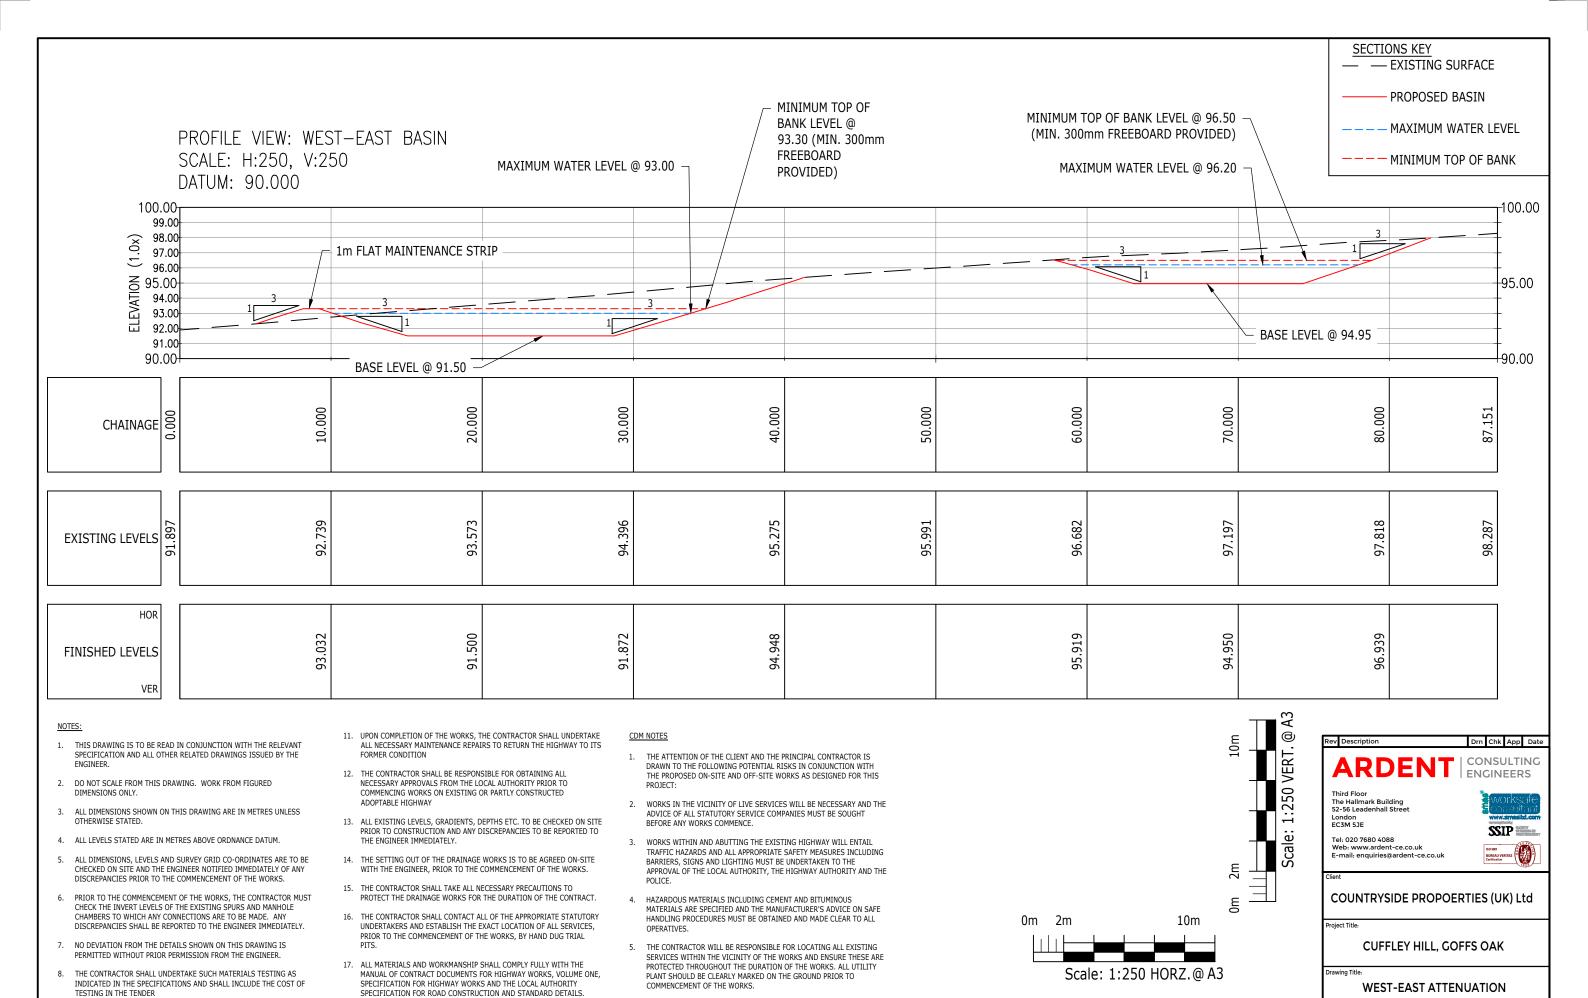
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FOR PLANNING

A3 Scale

1:500

BASIN SECTION


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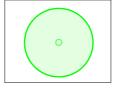


5 High Street, Great Bardfield, Essex, CM7 4RF


www.tracyclarke.co.uk

T: 01371 811831 / E: info@tracyclarke.co.uk


BS5837:2012 Tree Categorisation

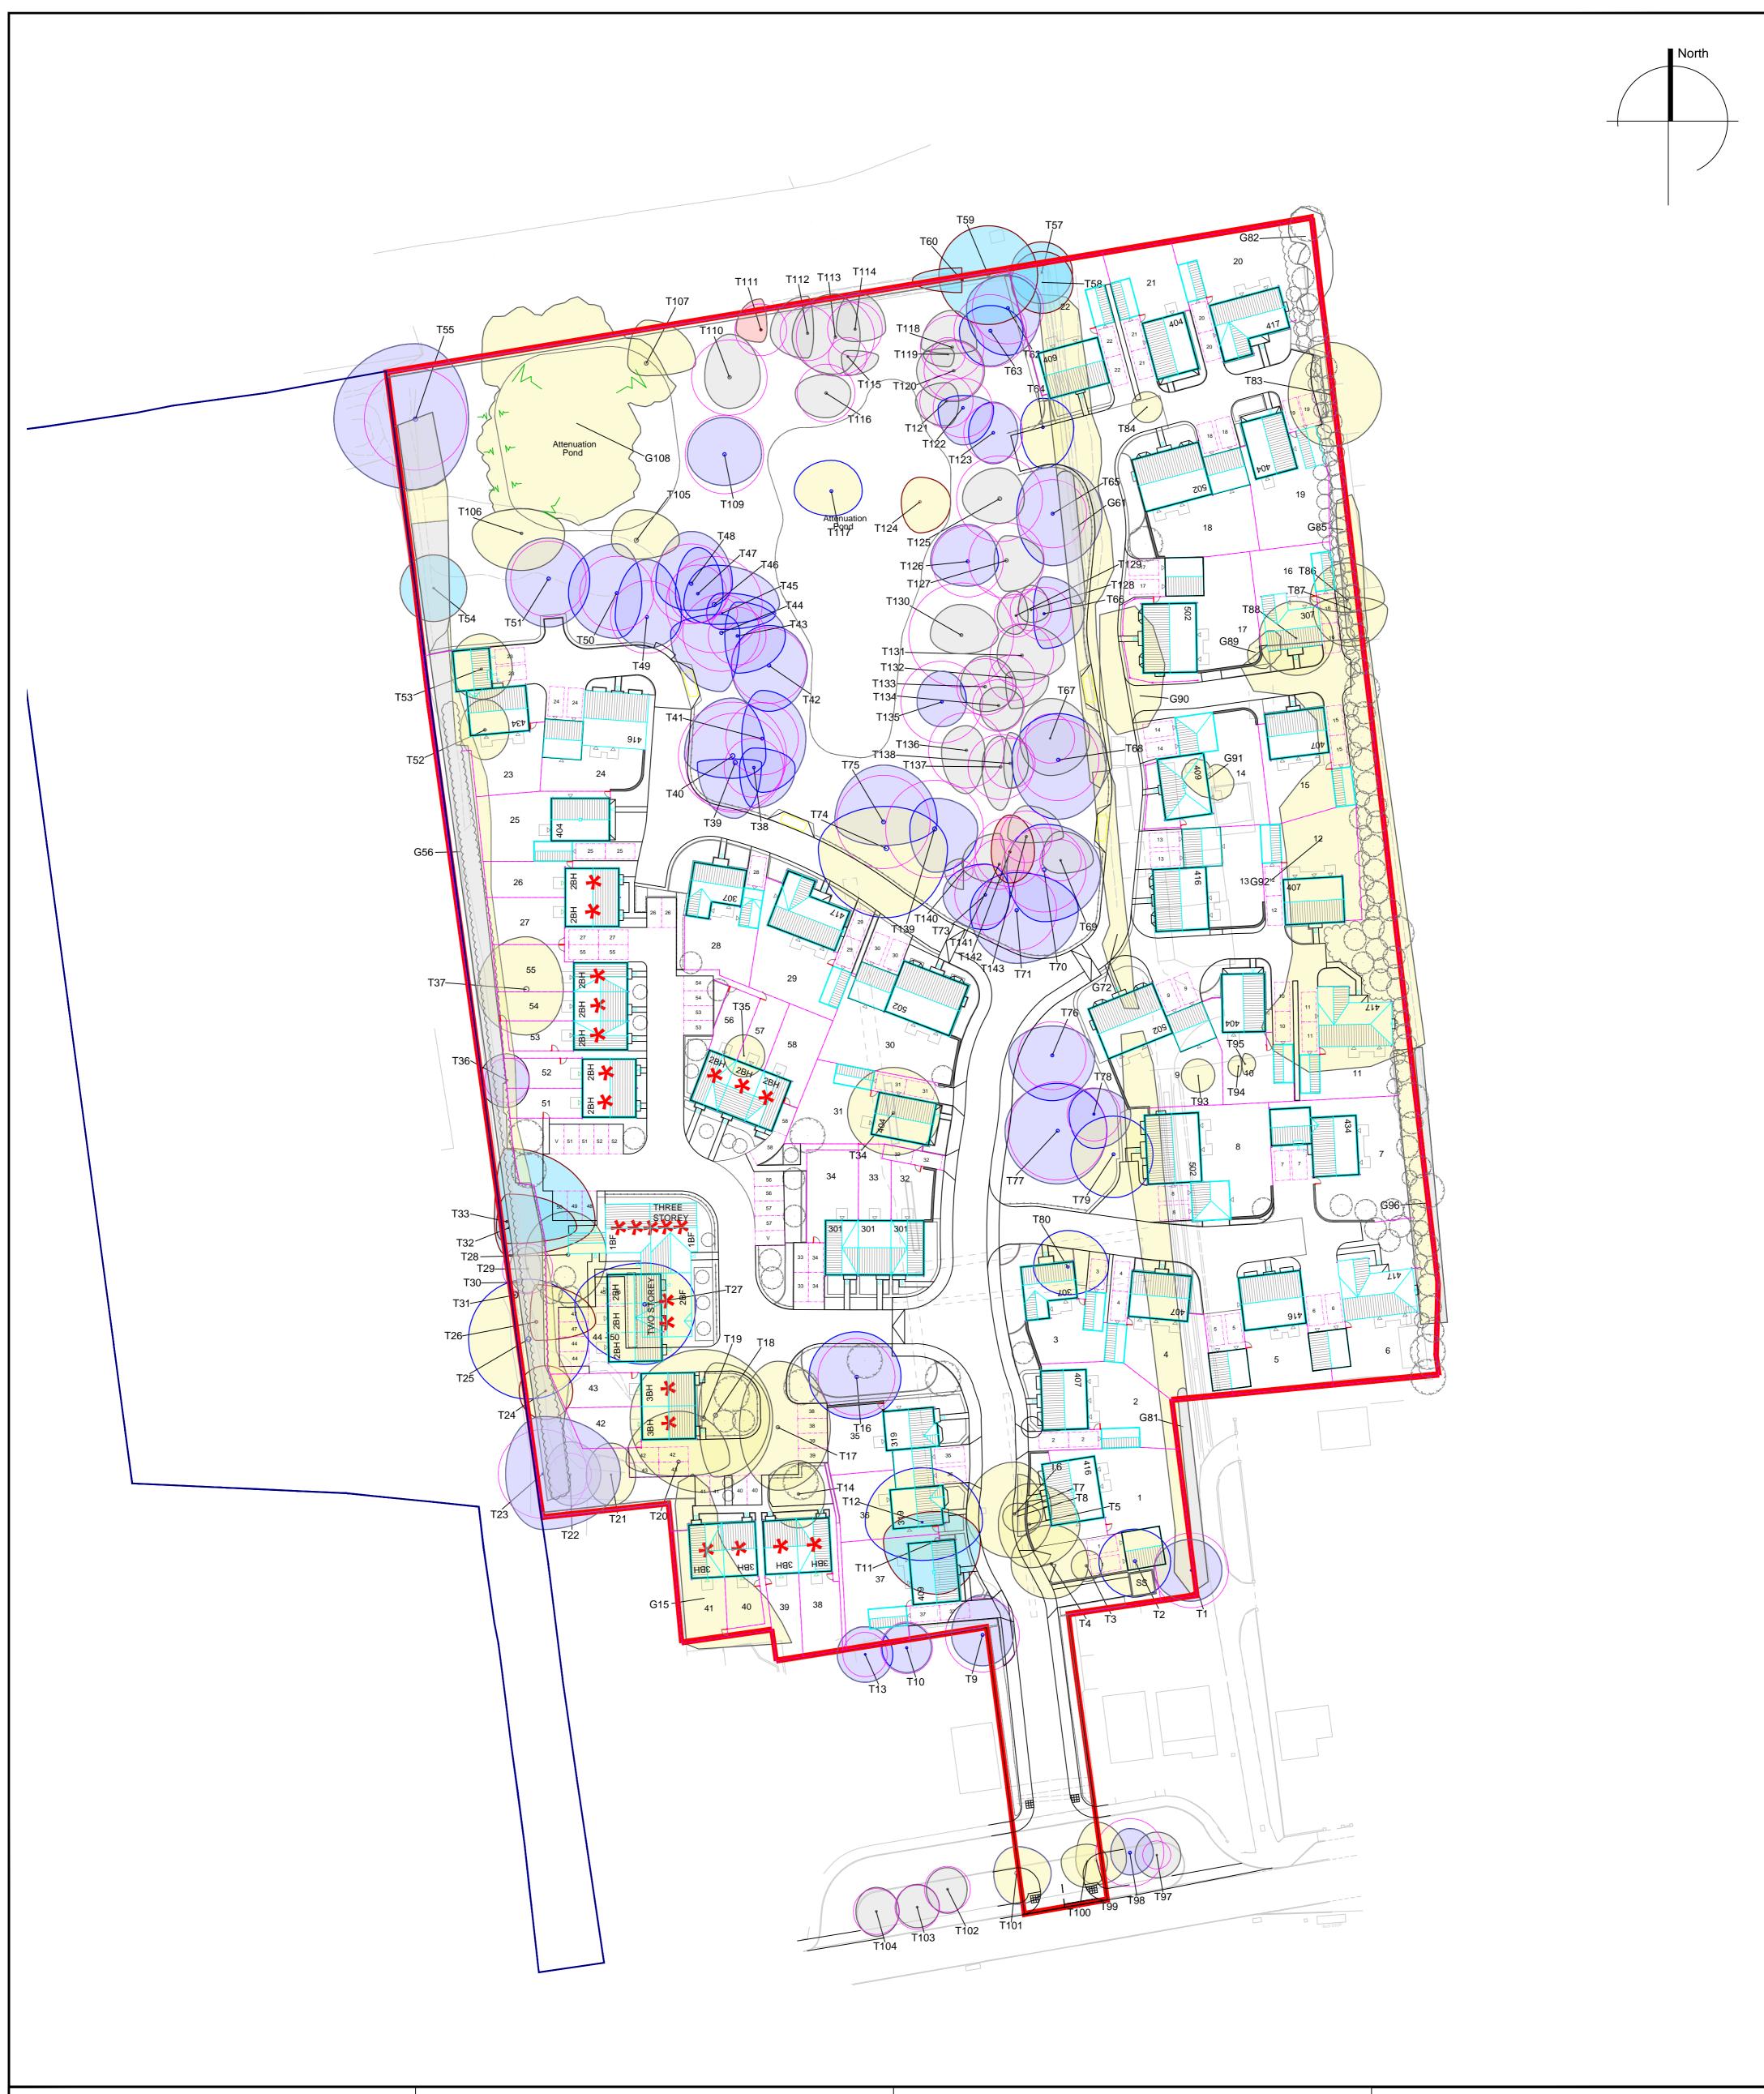


A Category
Trees of high quality with an estimated remaining life expectancy of at least 40 years

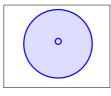

B Category
Trees of moderate quality with an estimated life expectancy of at least 20 years

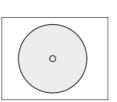


C Category
Trees of low quality with an estimated life expectancy of at least 10 years, or young trees with a stem diameter below 150mm

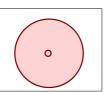

U Category
Those in such a condition that they cannot realistically be retained as living trees in the context of the current land use for longer than 10 years


Key

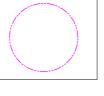

Root Protection Area (RPA)
The minimum area around a tree deemed to contain sufficient roots and rooting volume to maintain the trees viability.



Trees to be removed for development

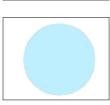

Trees to be removed for arboricultural reasons

0	5m	10m	20m	30m	40m	50m		
Date		Revision	Description	on				
10.10.18	}	A	Revisions to Tree Retention Site Plan SL.01.A*					
12.12.18		В	Updated s	ite layout SL	.01.B			
12.03.20		С	Updated s	ite lavout SL	.01.C			

Title

Proposed Layout


Client

Countryside Properties

Site Land at Cuffley Hill, Goffs Oak, Waltham Cross, EN7 5EU

Dwg Ref: TCTC-21217-PL-02Rev: CScale: 1:500 @ A1Status: PlanningDate: August 2018Drawn By: AC

Do not scale from this drawing, tree positions and dimensions should always be checked on site. The original of this drawing is in colour, do not rely on monochrome versions. This drawing is copyright Tracy Clarke Tree Consultancy Ltd.

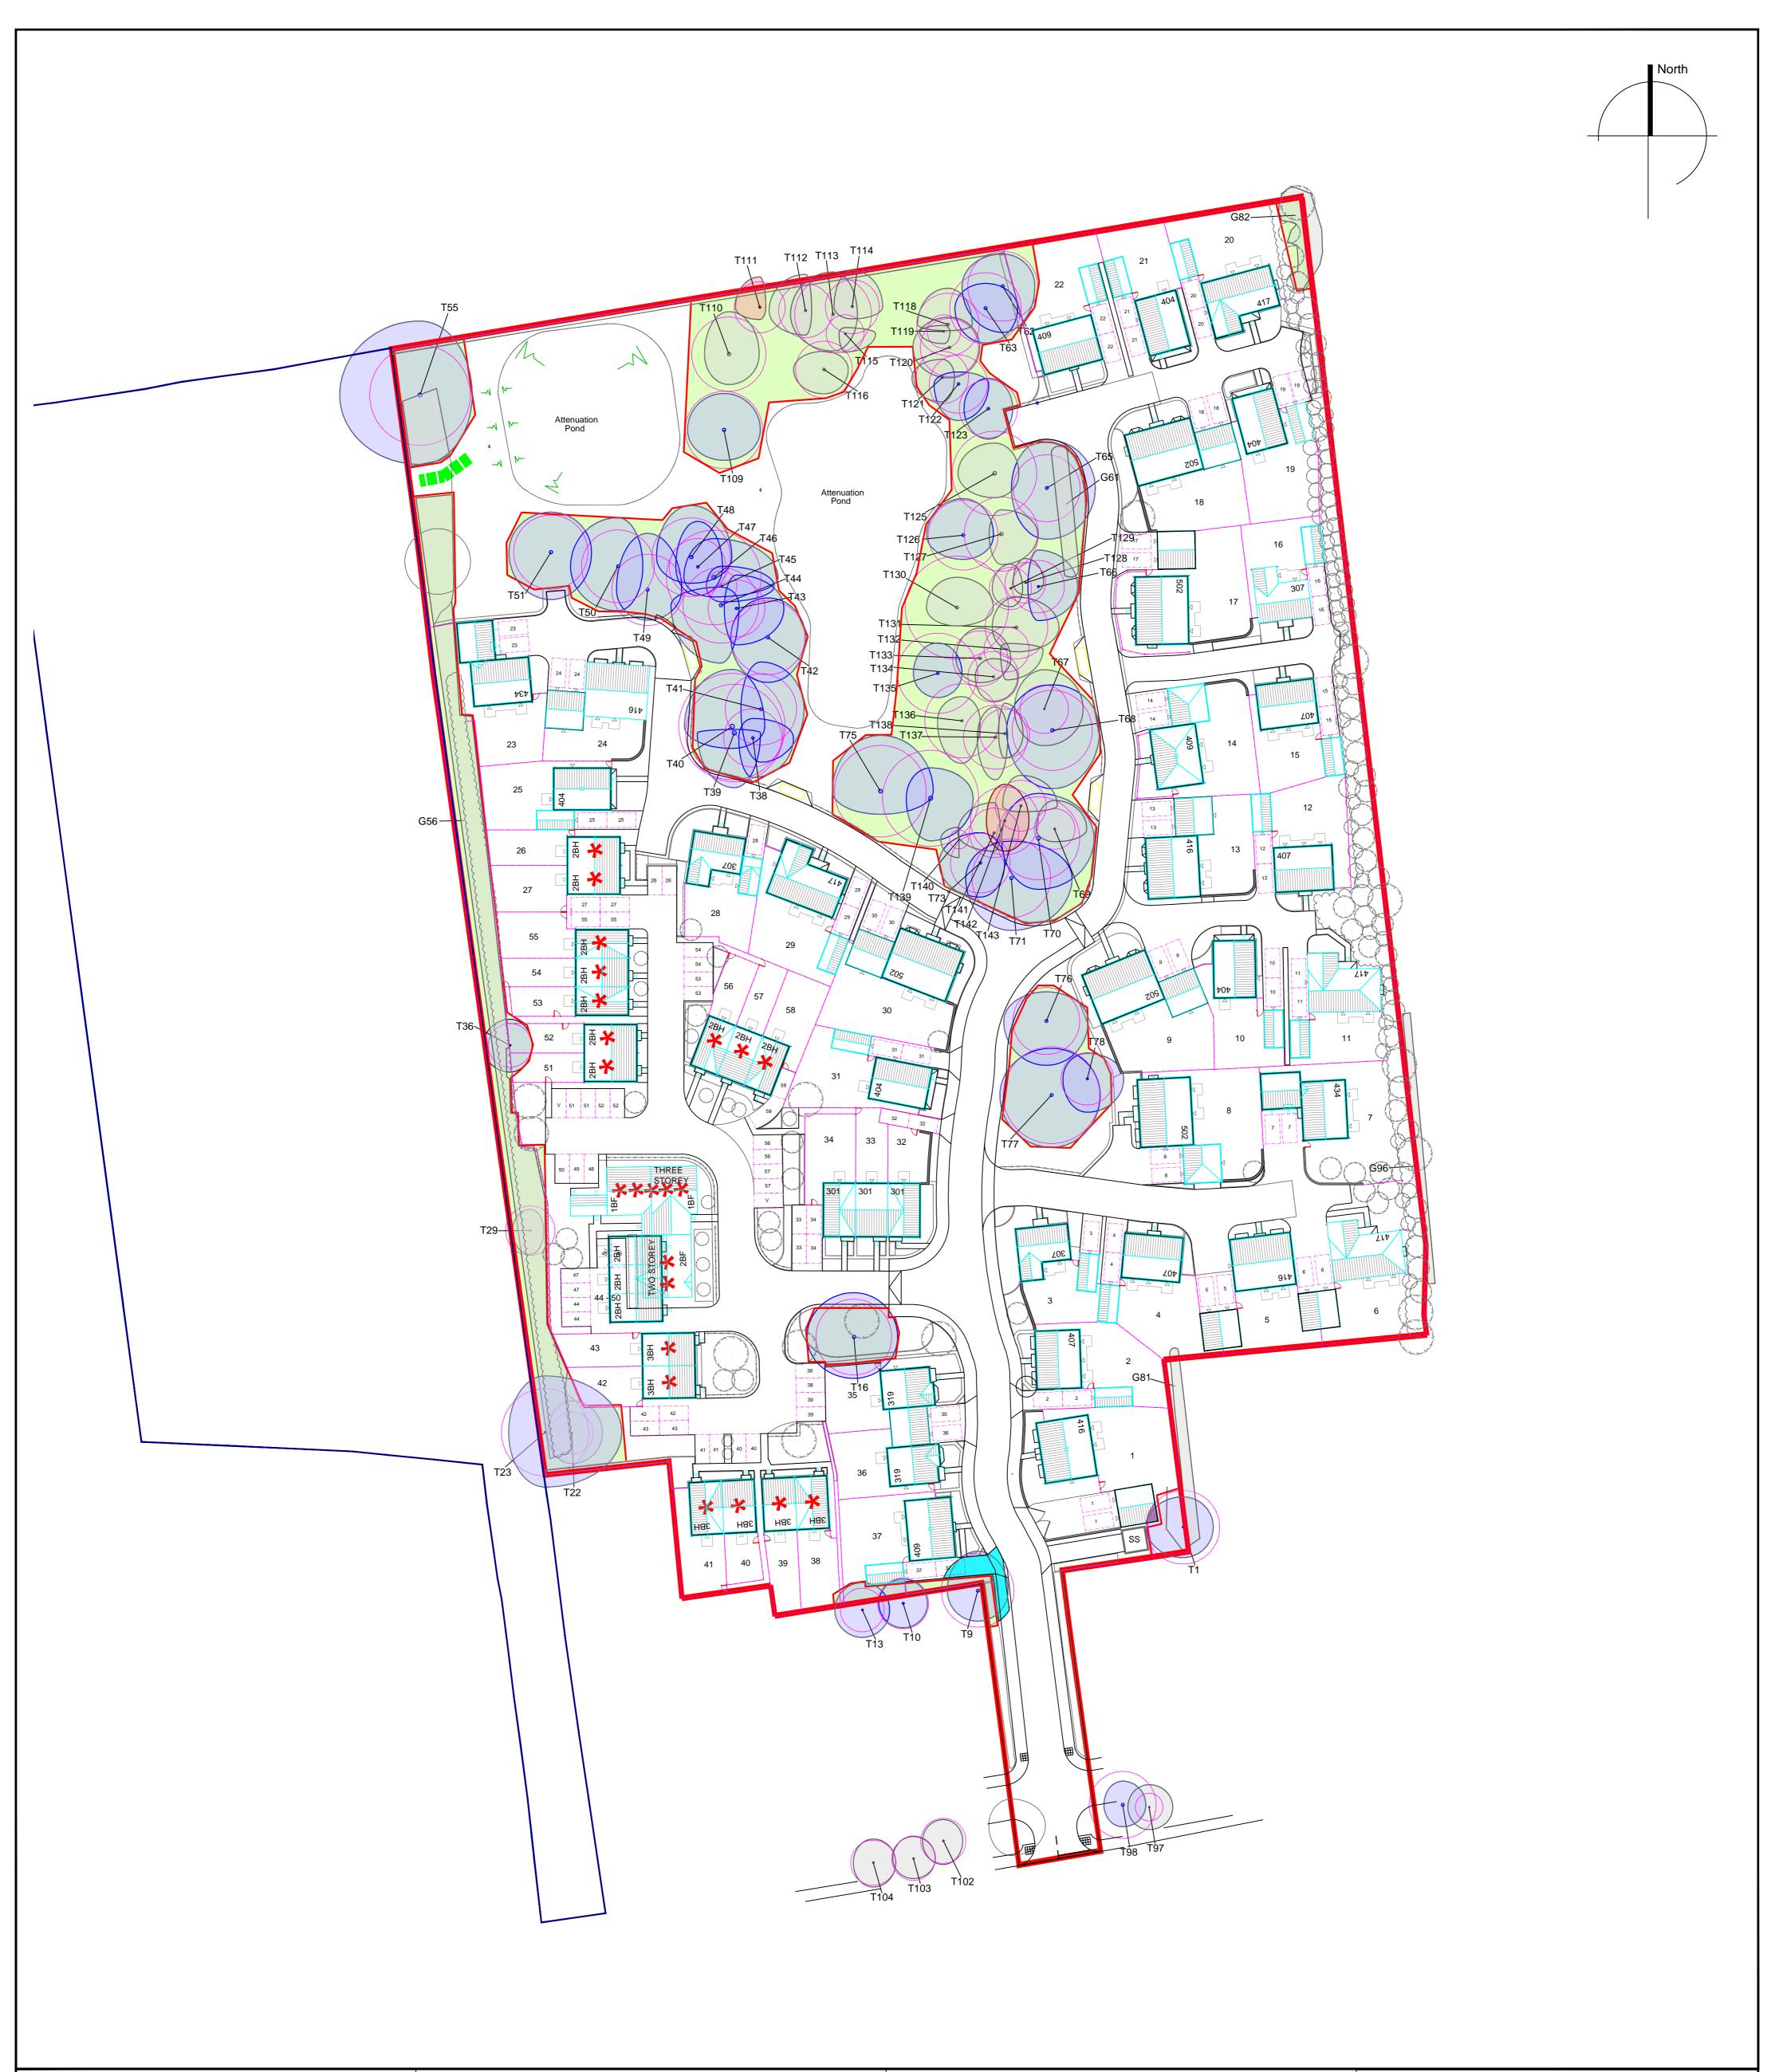



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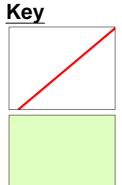
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BS 5837 2012 Default weldmesh specification for protective barrier

Construction exclusion zone

No-dig construction Permeable hard surface

Foundation construction requiring specialist approach

0	5m	10m	20m	30m	40m	50m		
Date	Re	vision	Description	1				
10.10.18 A			Revisions to Tree Retention Site Plan SL.01.A*					
12.12.18	.18 B Updated site layout SL.01.B							
12.03.20		С	Updated site	e layout SL.0	1.C			

Title Tre

Tree Protection Plan

Client

Countryside Properties

Site Land at Cuffley Hill, Goffs Oak, Waltham Cross, EN7 5EU

Dwg Ref: TCTC-21217-PL-03Rev: CScale: 1:500 @ A1Status: PlanningDate: August 2018Drawn By: AC

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